
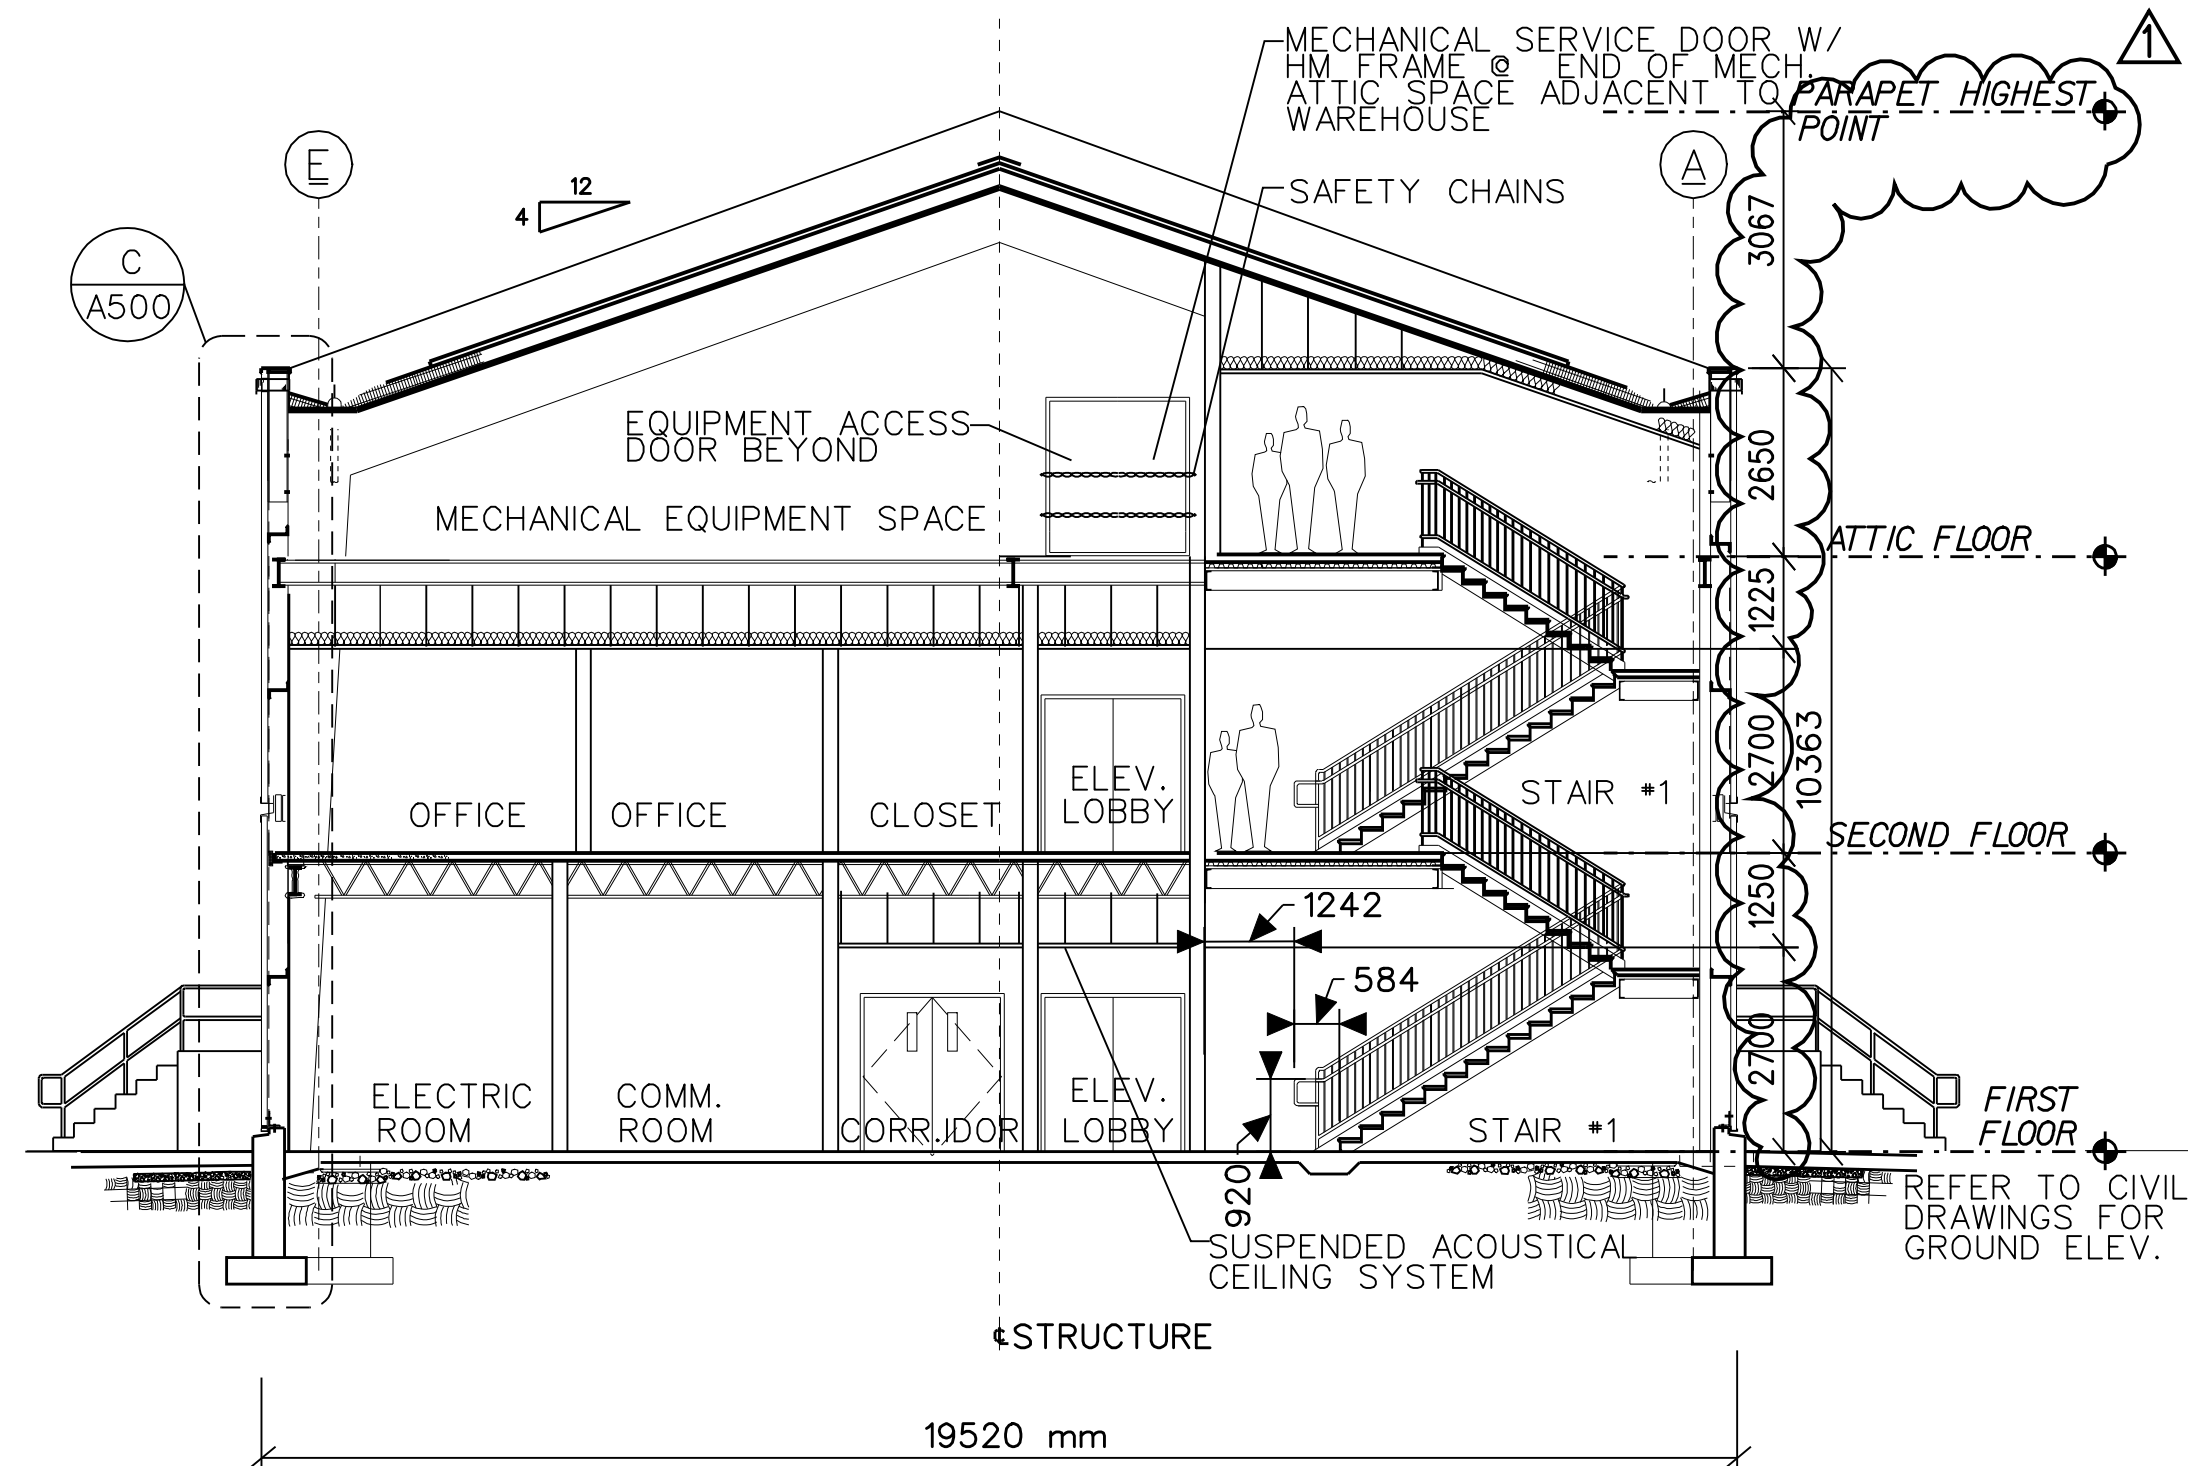


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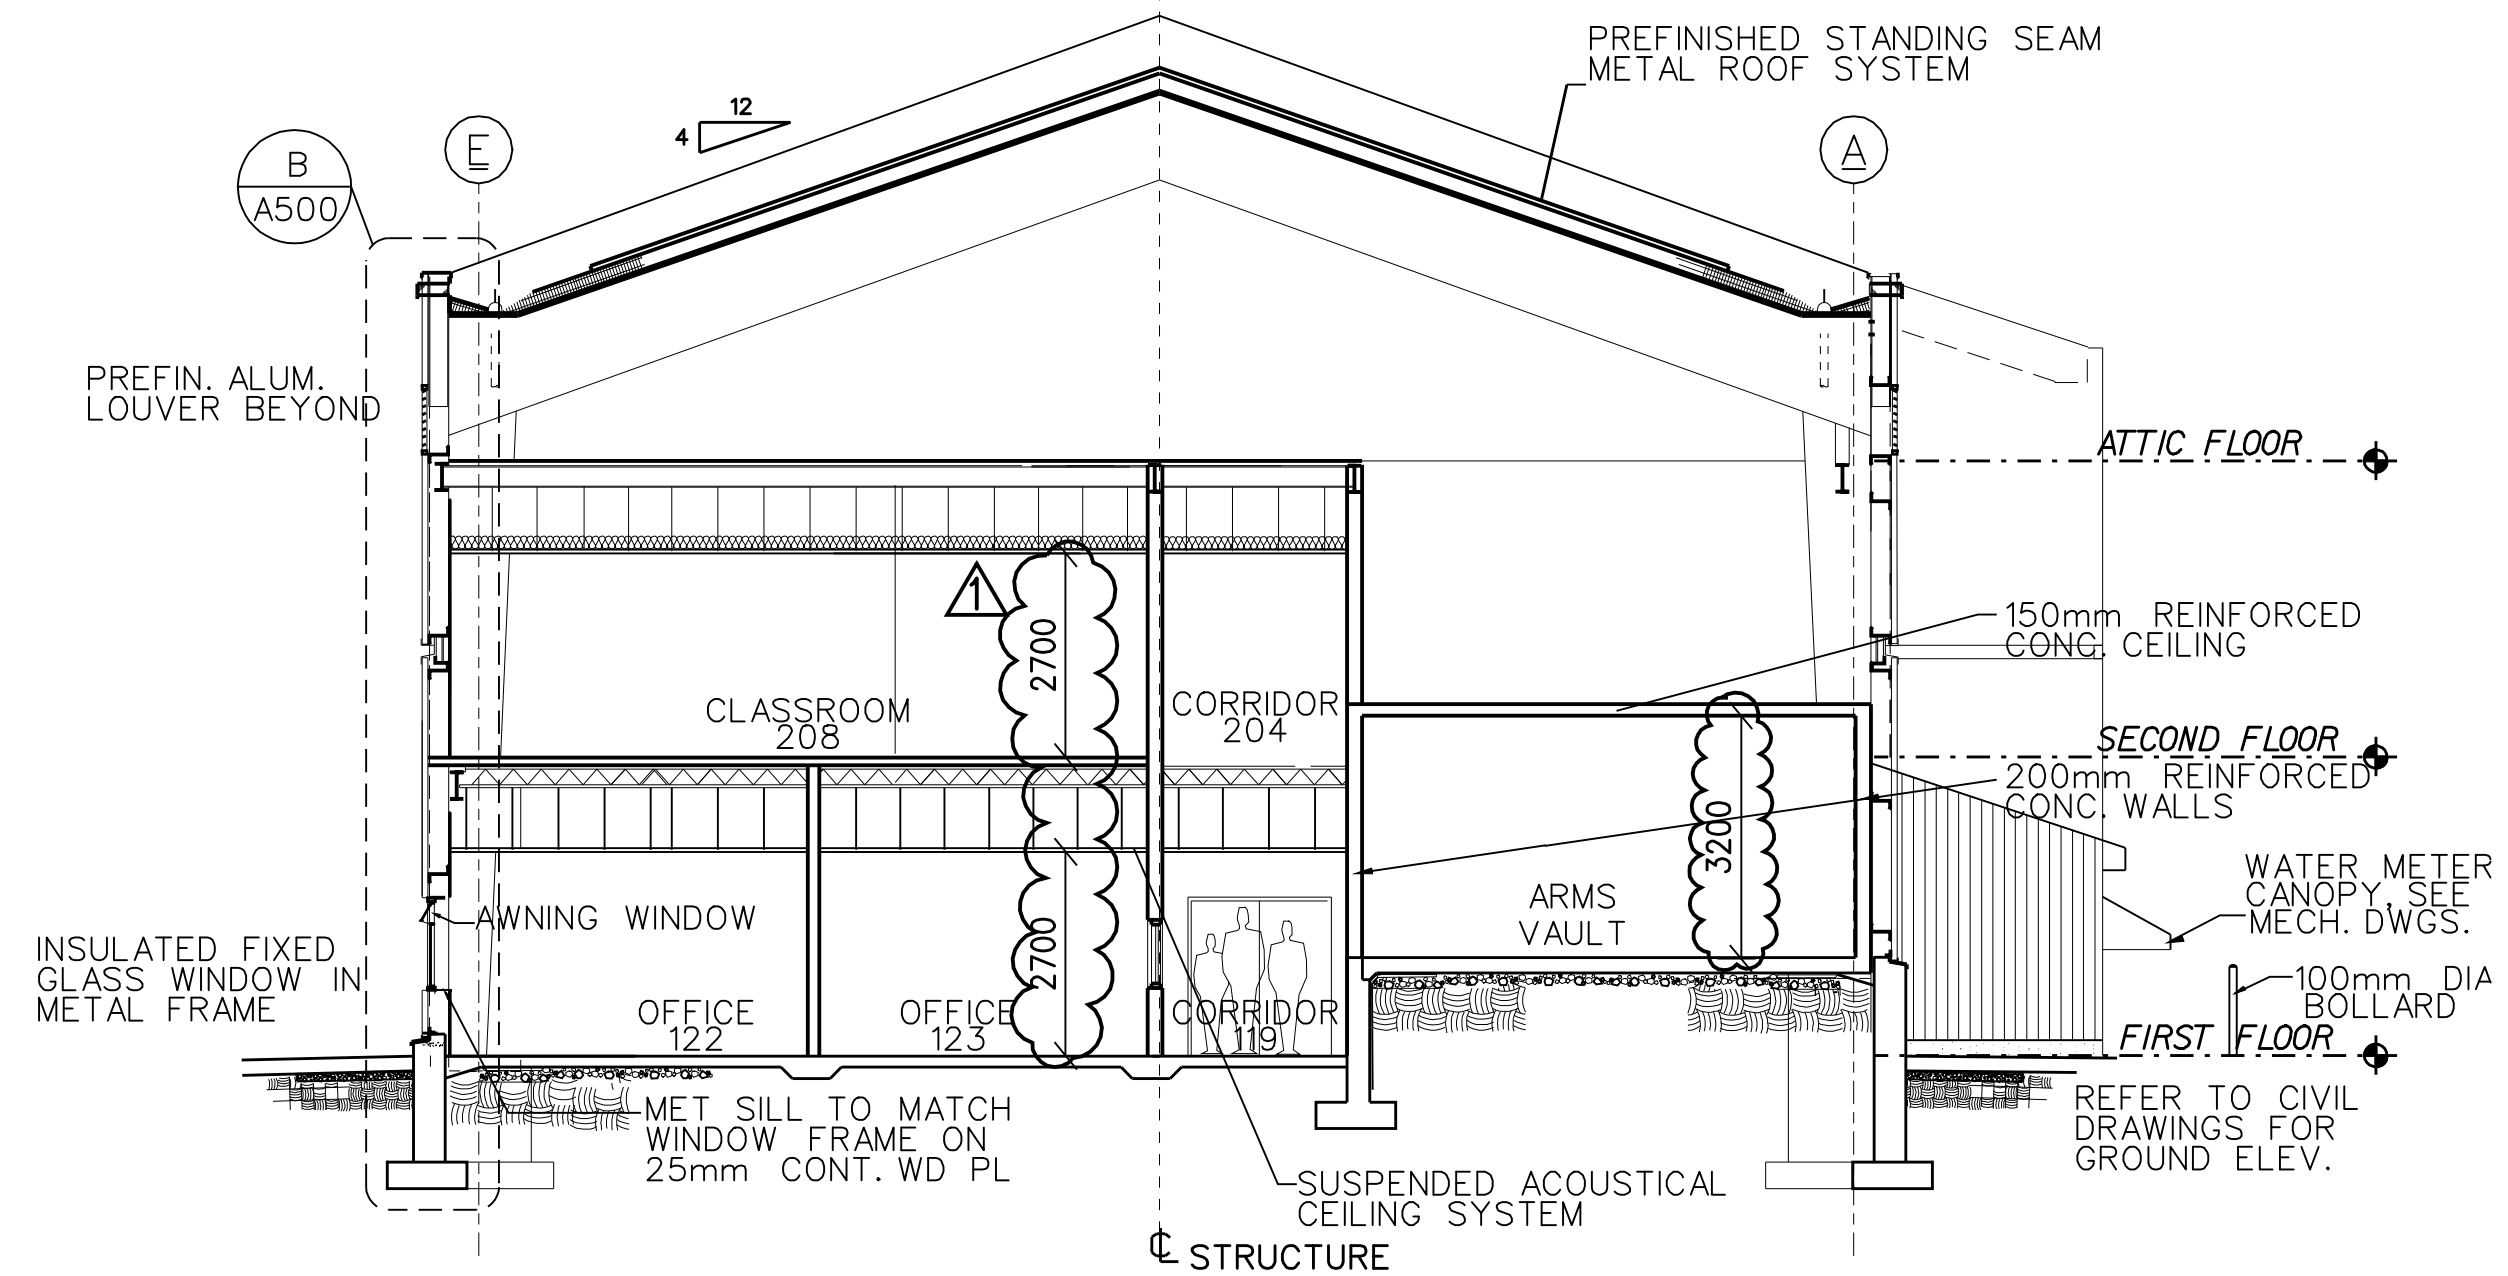


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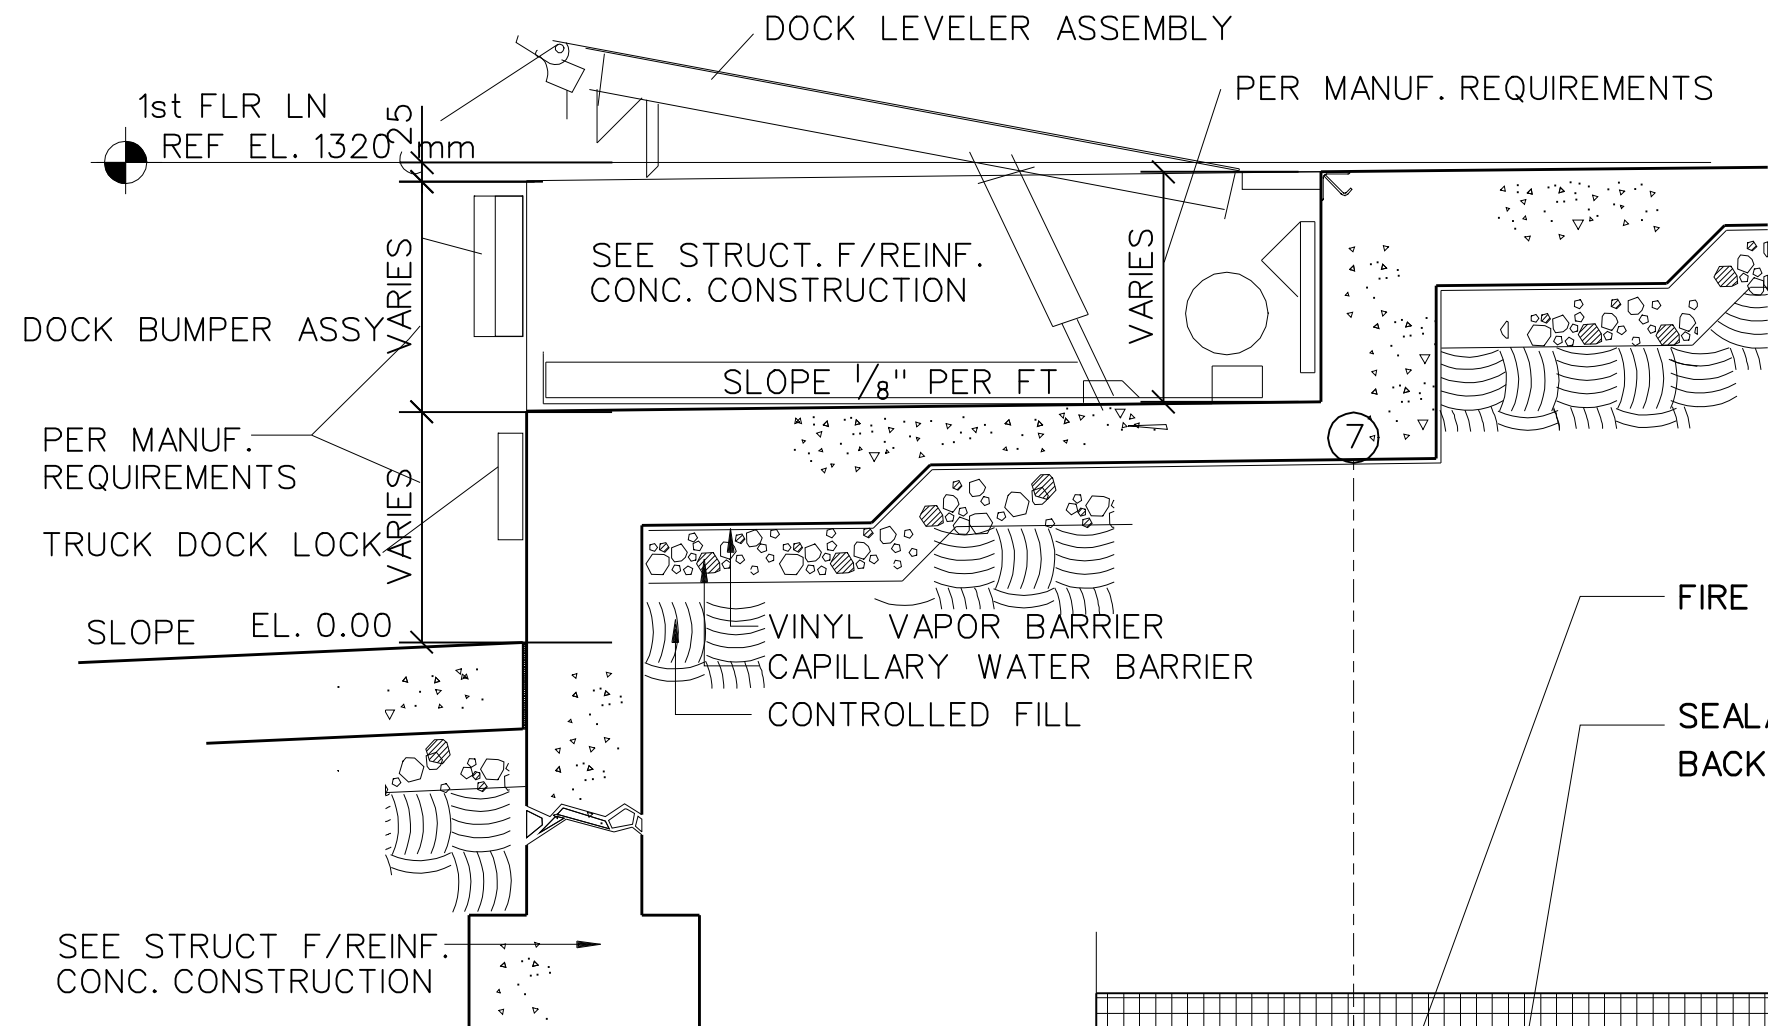


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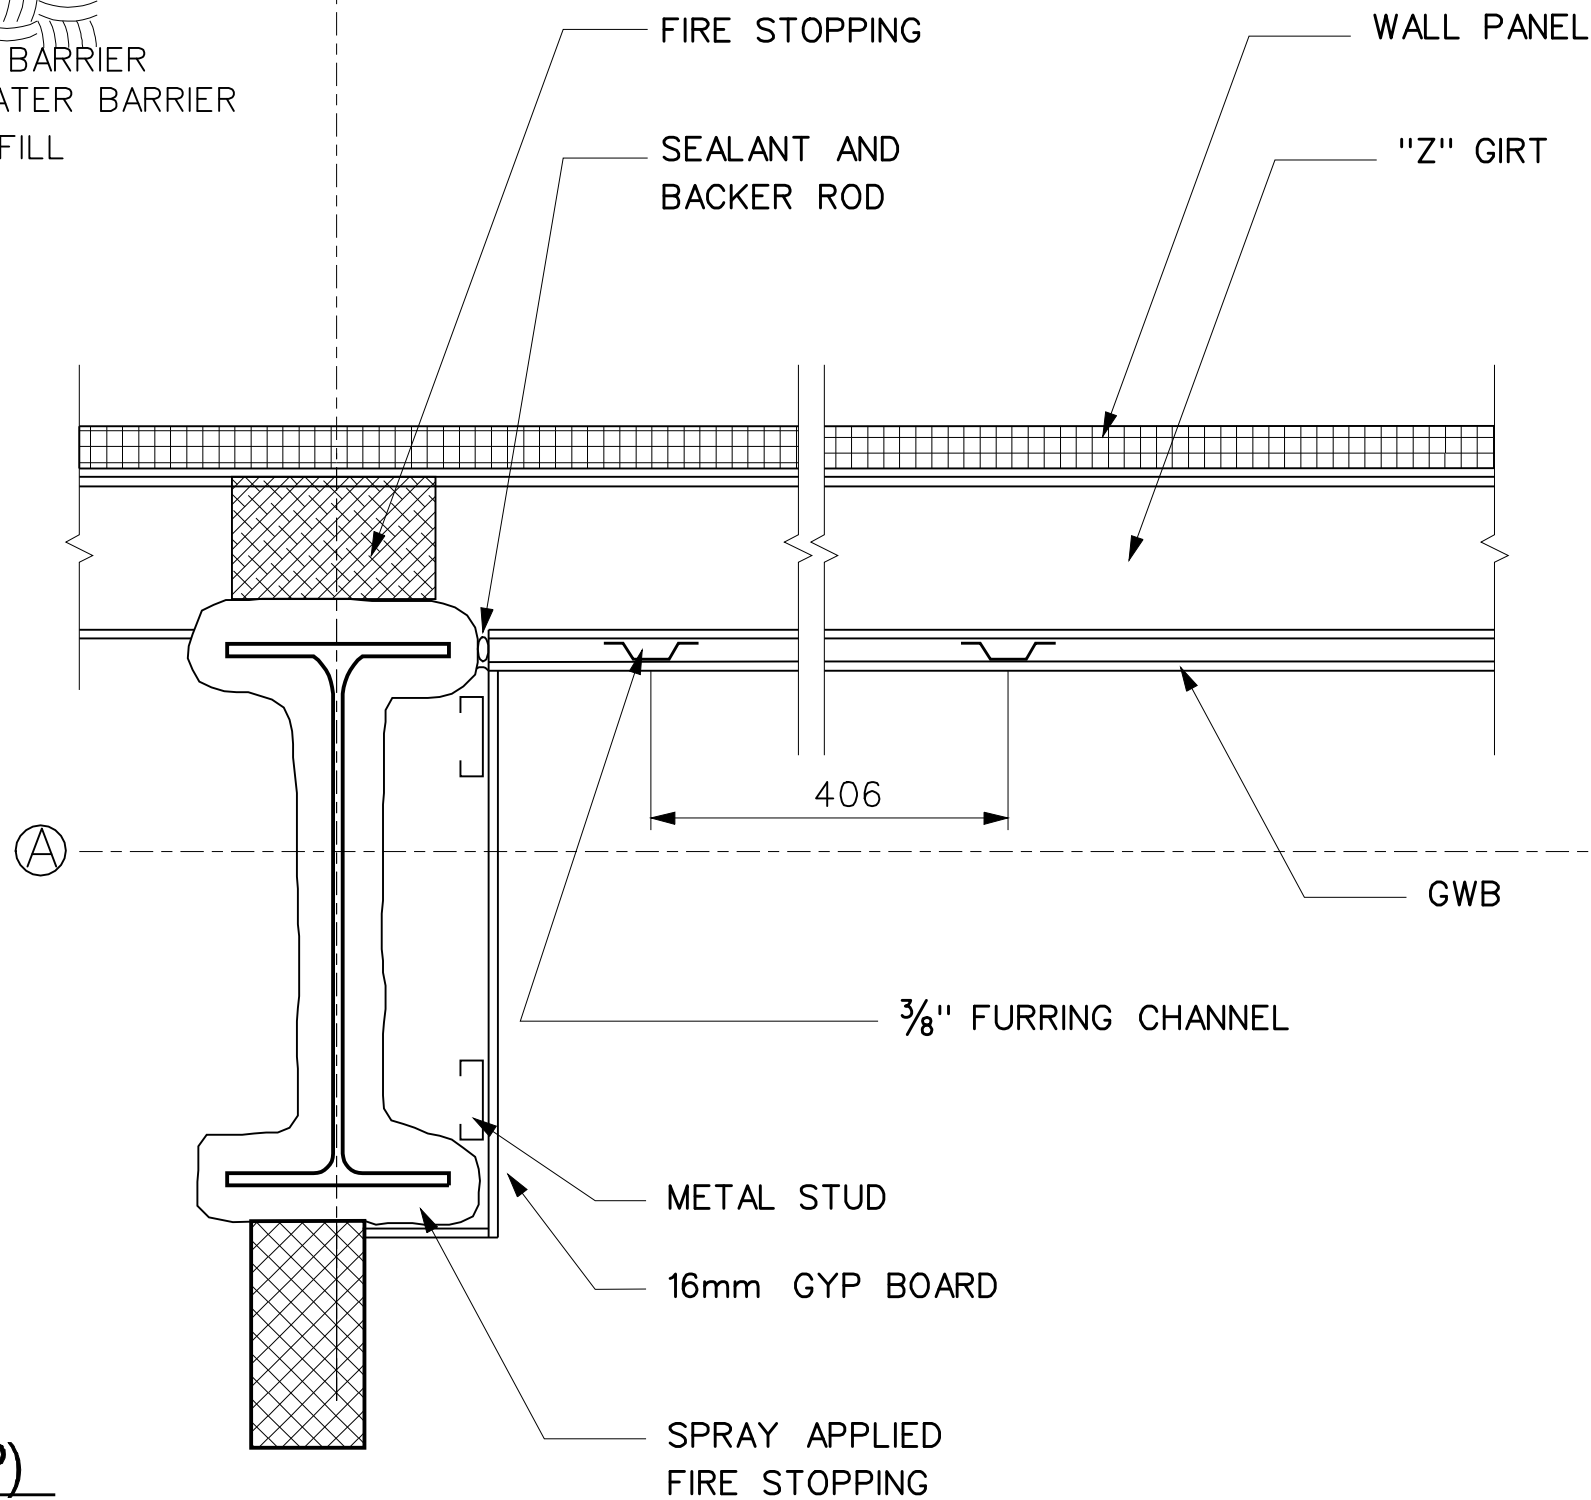
ALL DIMENSIONS ARE IN MILLIMETERS

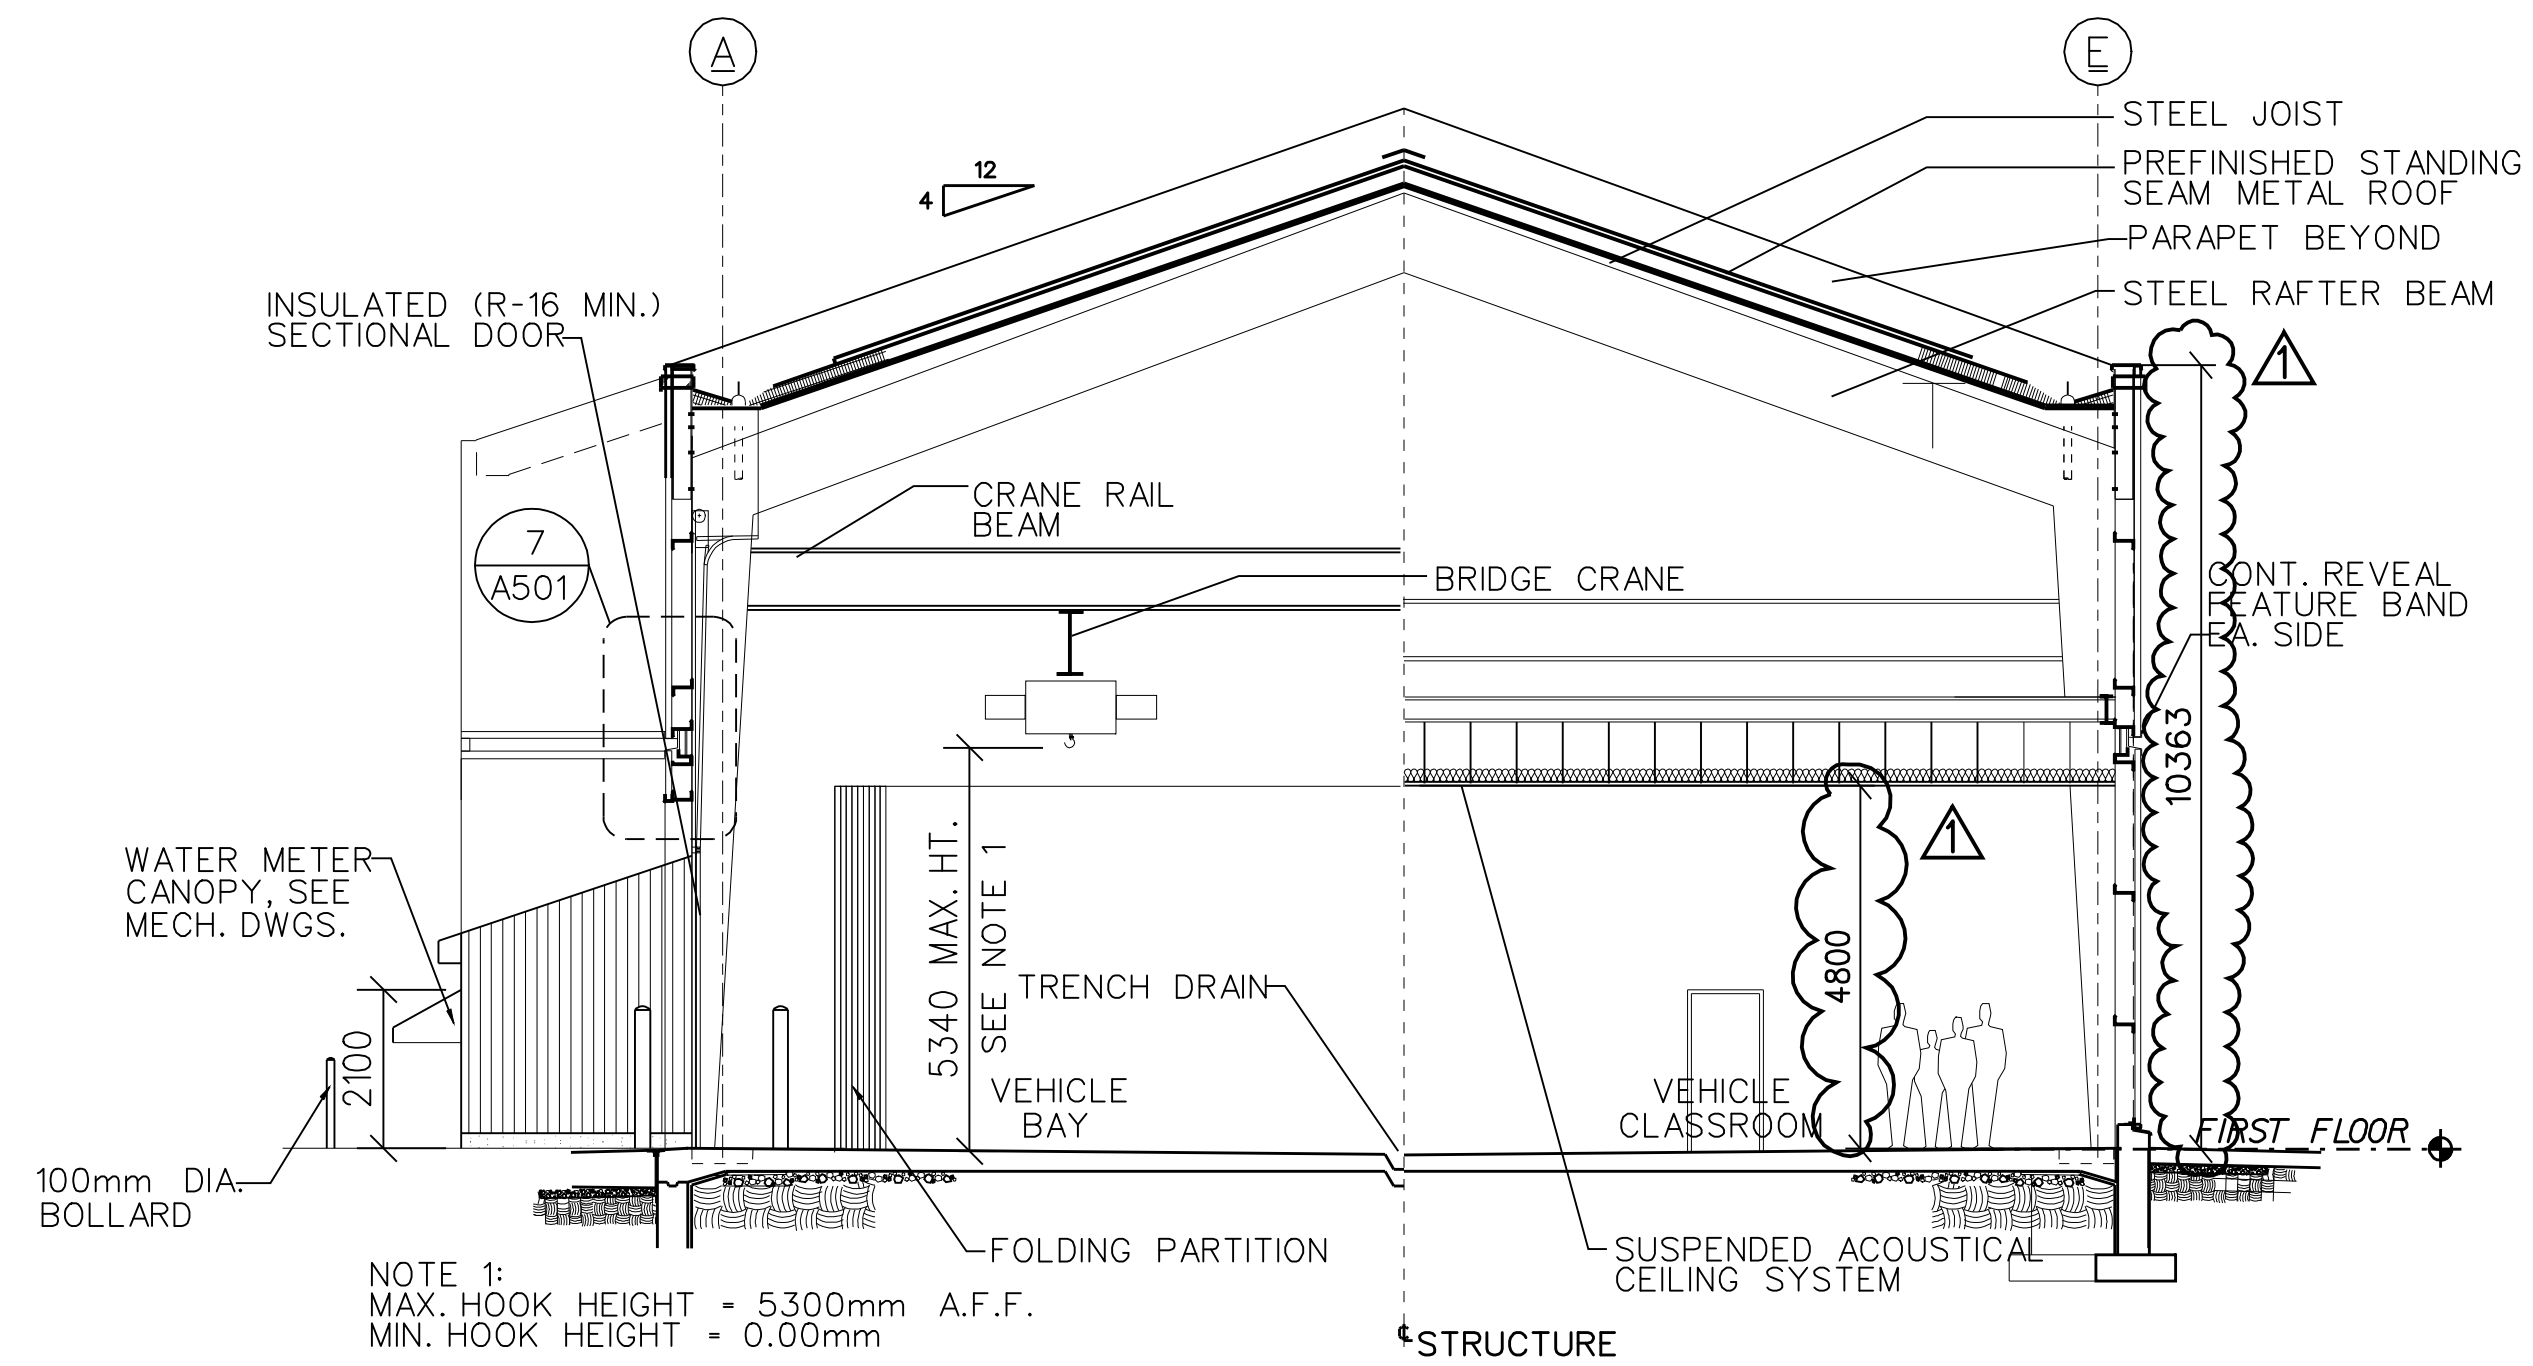

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1A LOADING DOCK SECTION  
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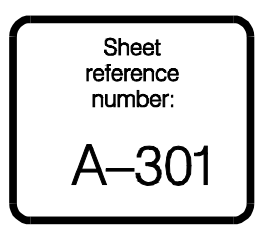
2A FIRESTOPPING DETAIL (TYP)  
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US Army Corps of Engineers  
New York District

Design by:	Drawn by:	Check by:	Date:
U.S. Army Engineer District Fort Drum, New York	U.S. Army Engineer District Fort Drum, New York	U.S. Army Engineer District Fort Drum, New York	25-AUG-2005

SECTION

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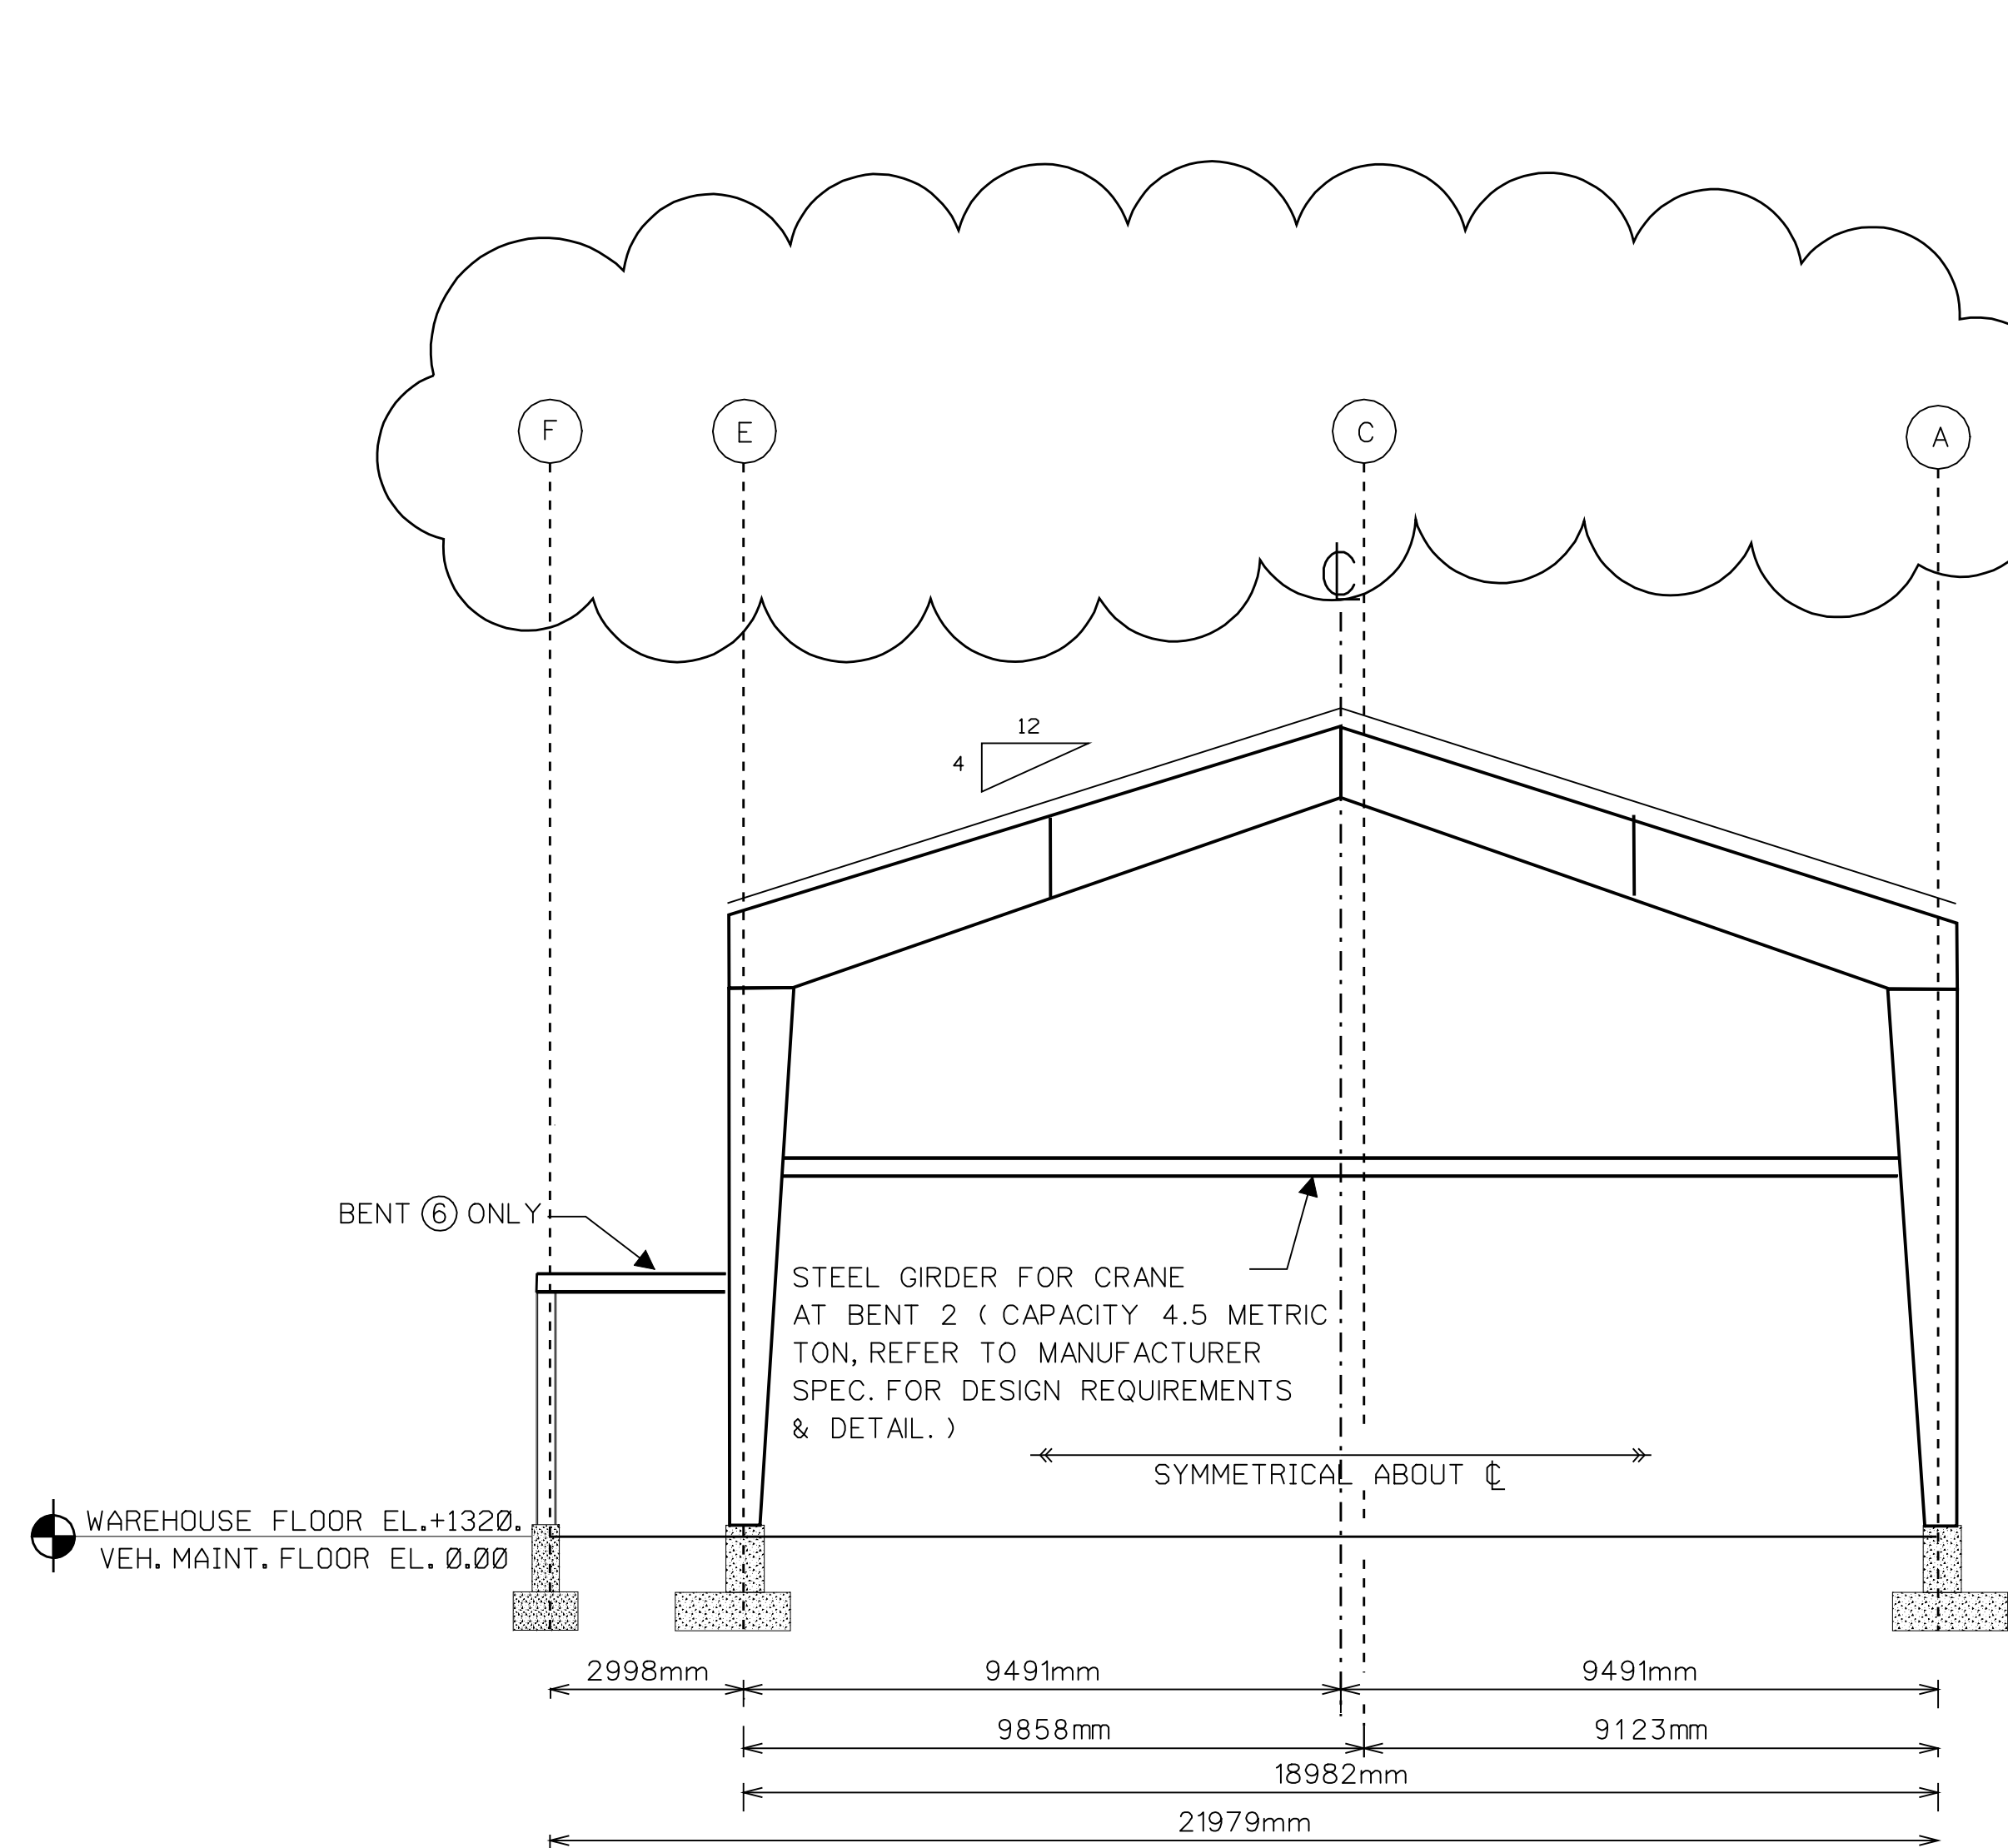
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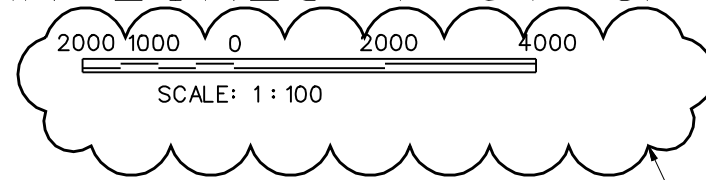
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PR 57708  
FORCE MODERNIZATION EDUCATION /TRANSITIONAL FACILITY  
FORT DRUM, NEW YORK  
TYPICAL FRAME ELEVATIONS

Sheet  
reference  
number:  
**S-201**




VEHICLE MAINTENANCE, & WAREHOUSE  
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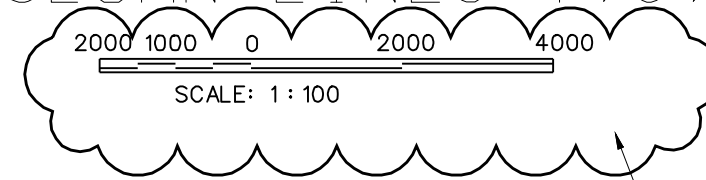


NOTES

1. SEE S-001 FOR GENERAL NOTES AND DESIGN REQUIREMENTS FOR METAL BUILDING SYSTEM.
2. SEE S-101 FOR FOUNDATION PLAN AND S-501 FOR TYPICAL FOUNDATION DETAILS.
3. SEE ARCHITECTURAL DRAWINGS FOR WINDOWS, DOORS AND RELATED OPENING INFORMATION.

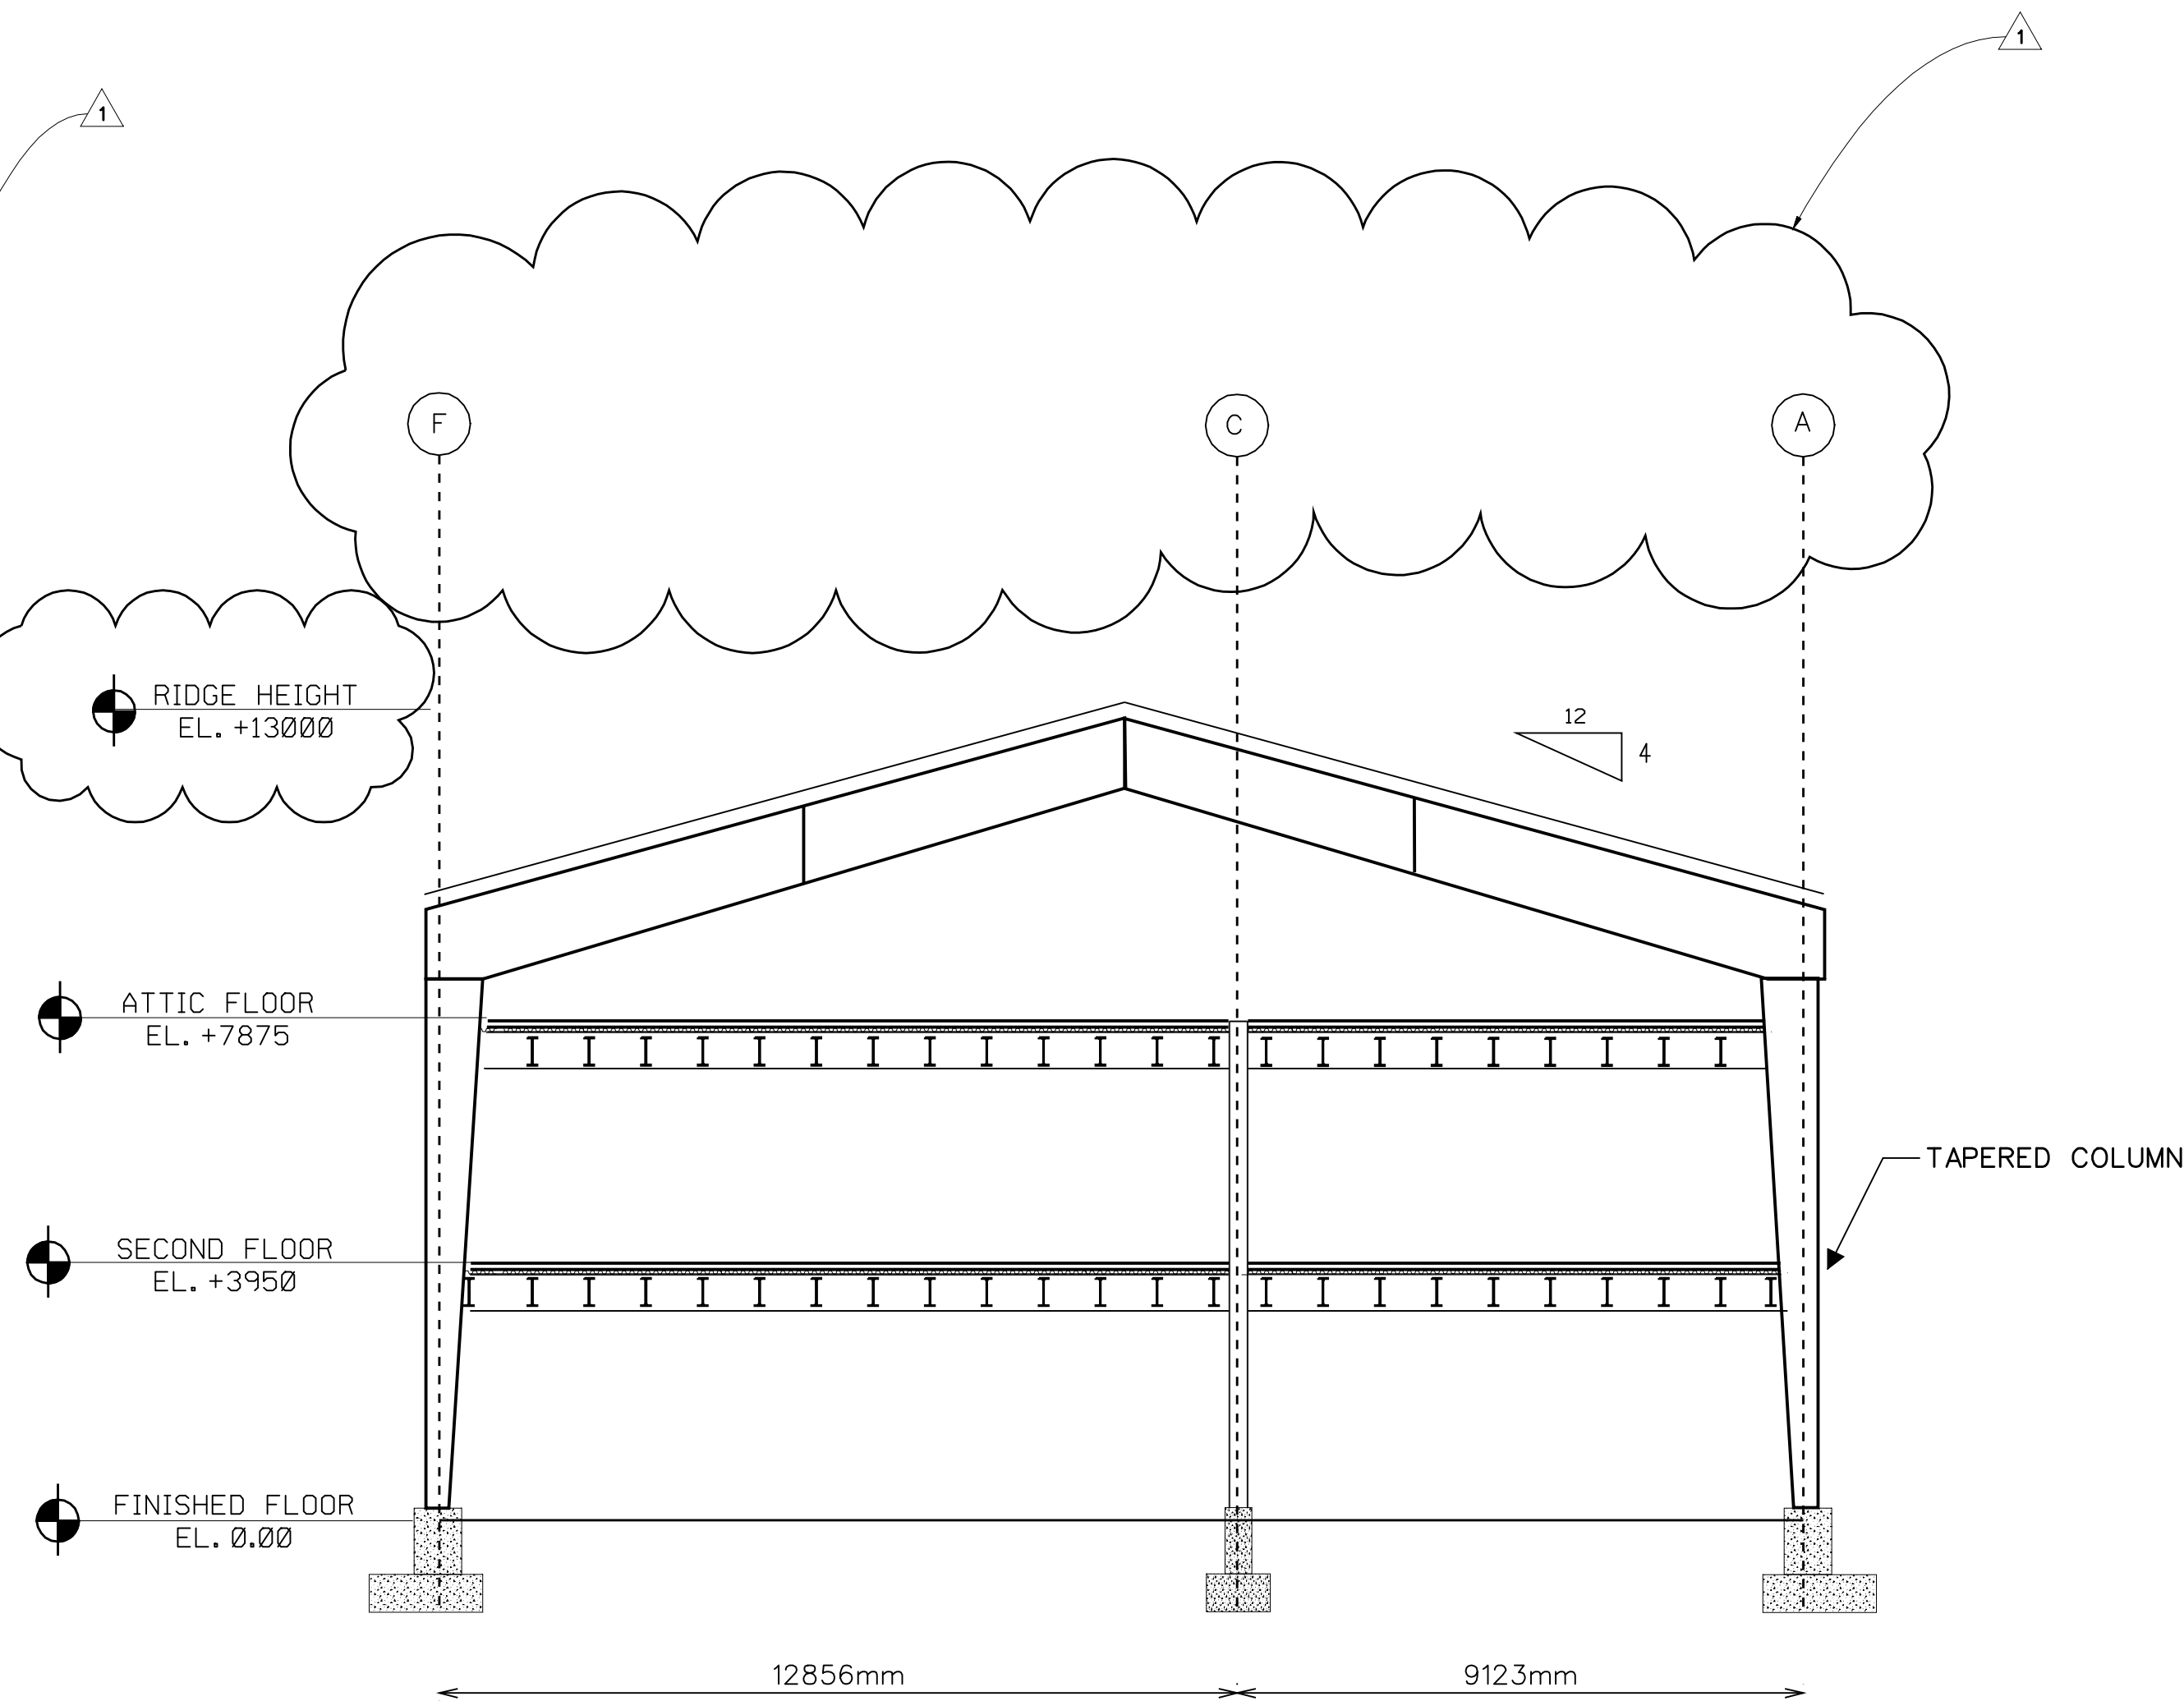


ADMINISTRATIVE BUILDING  
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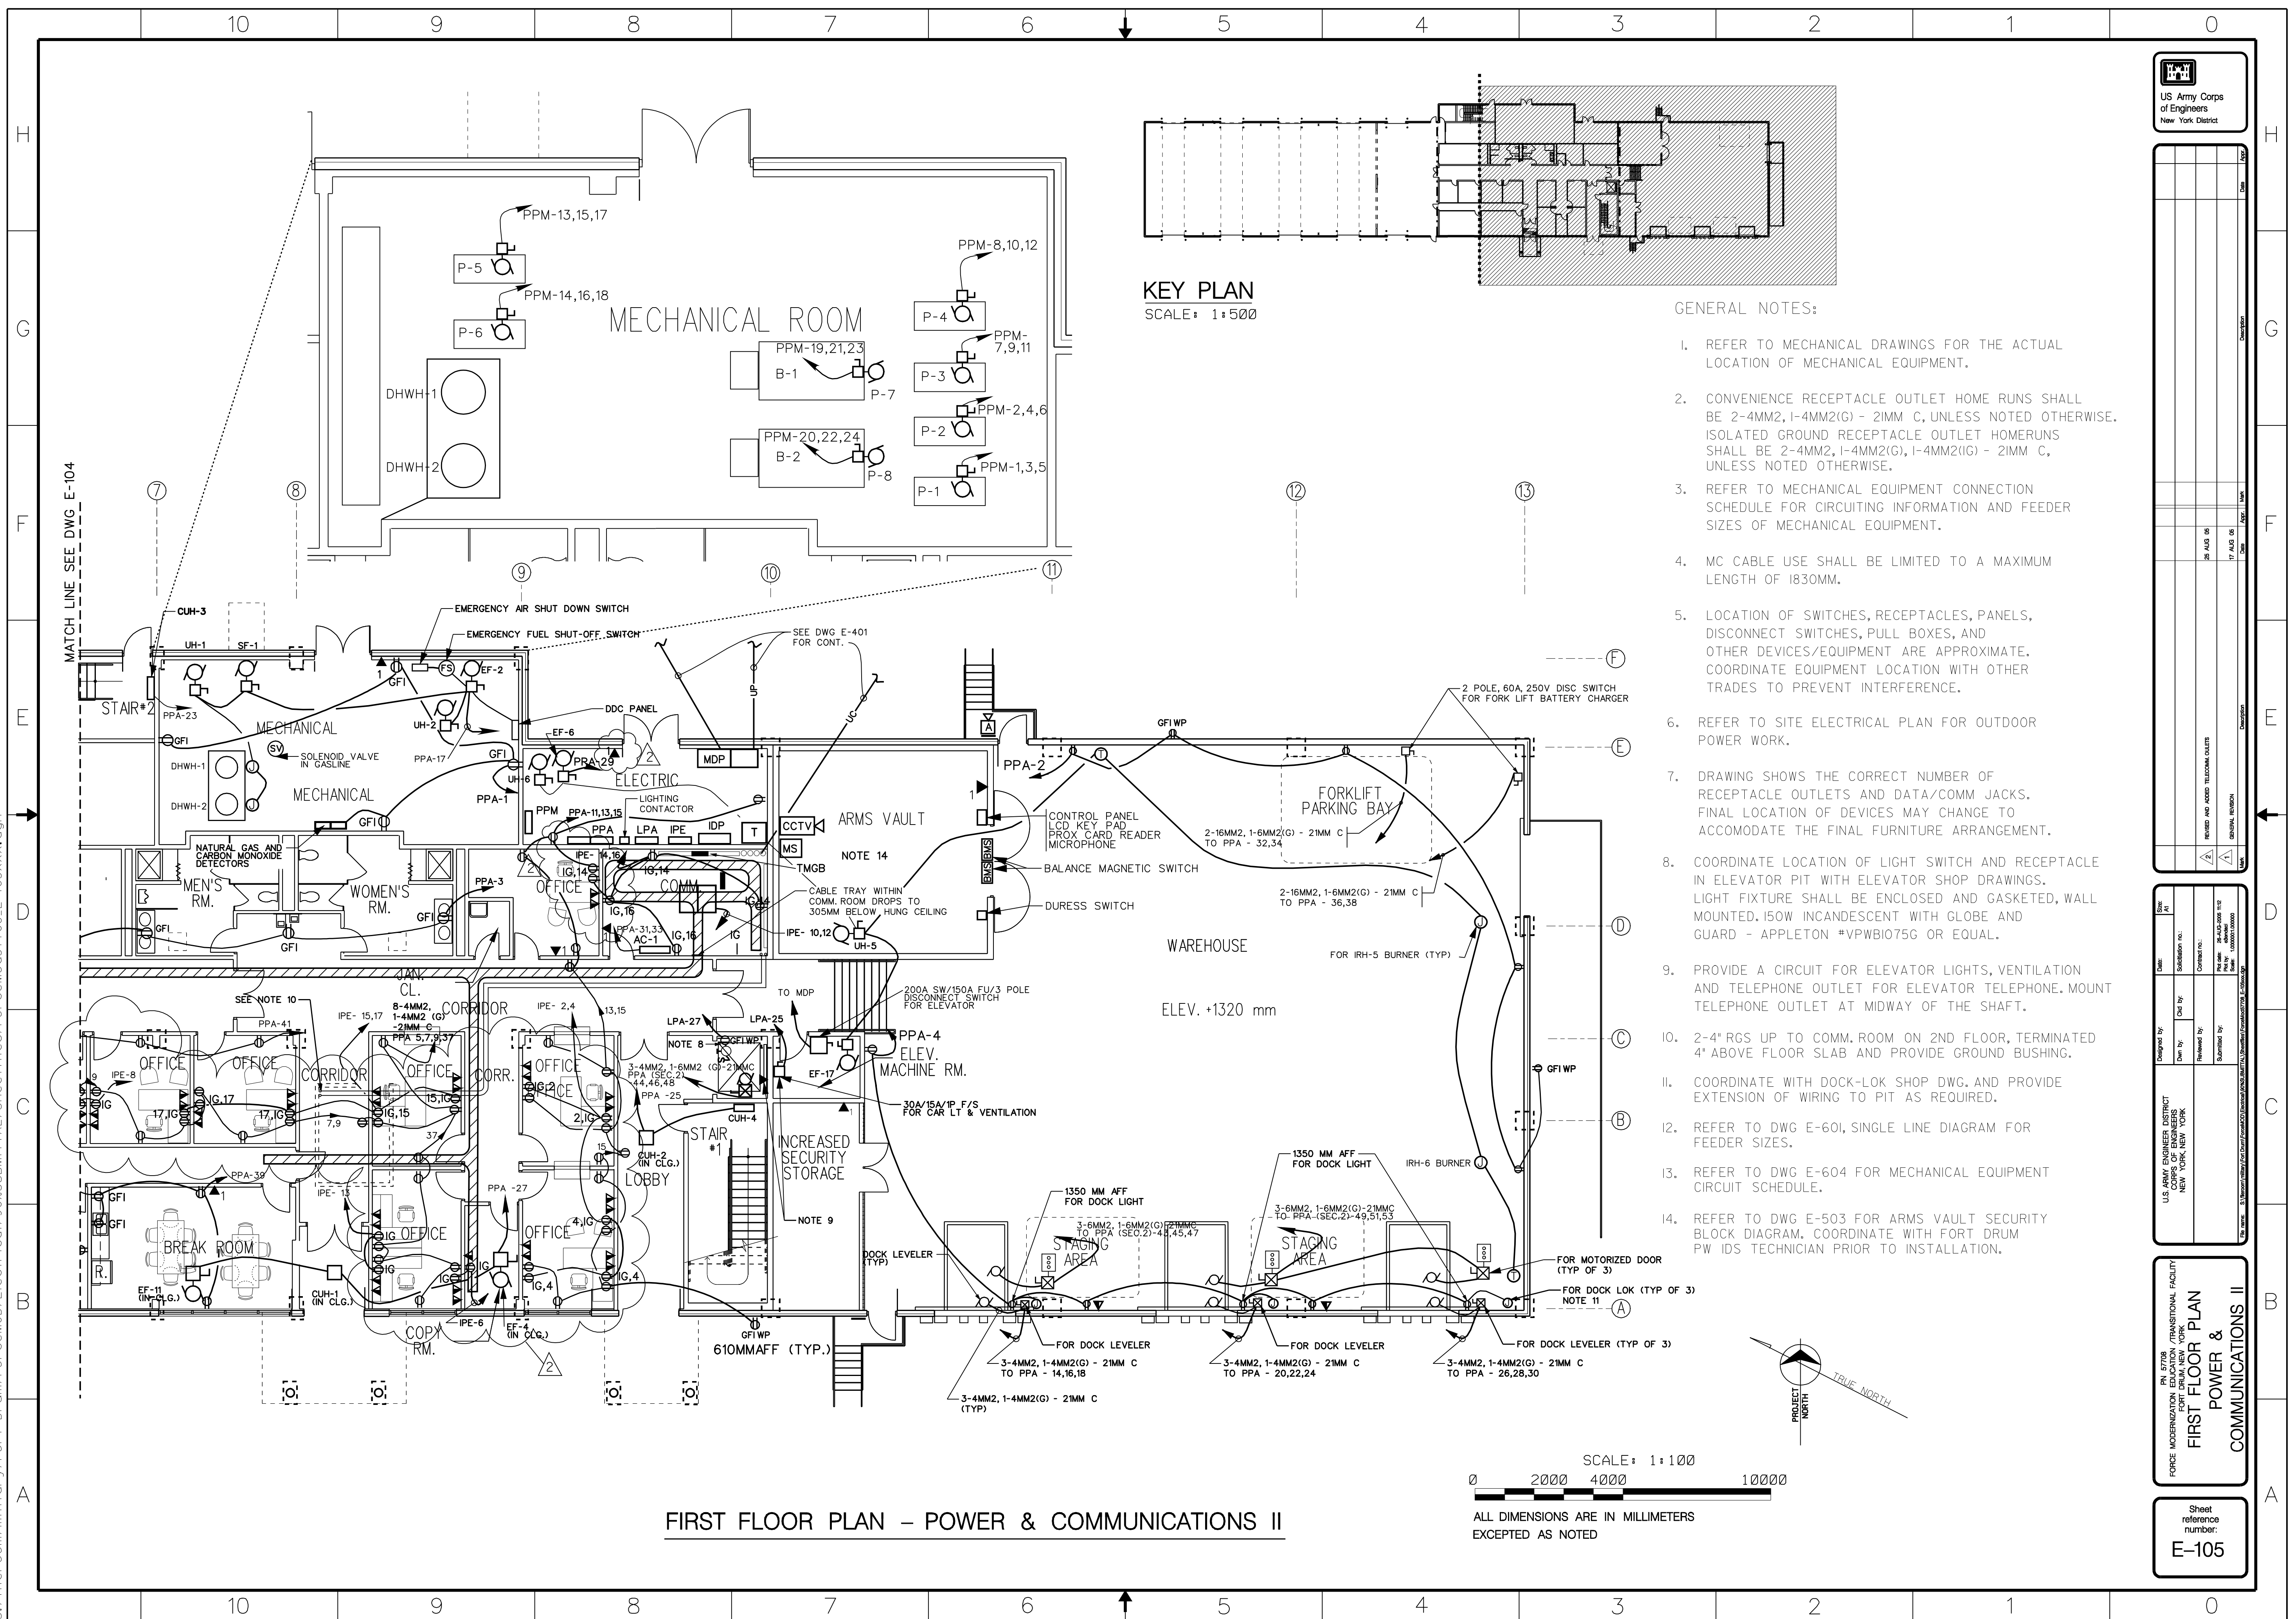






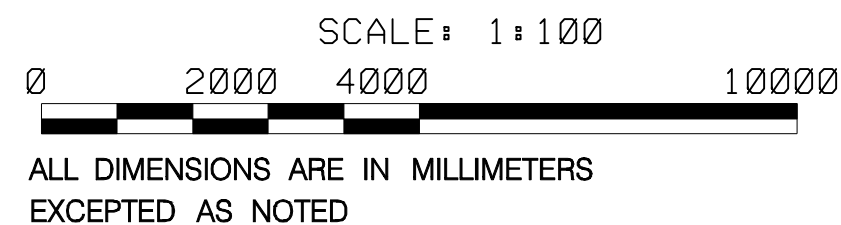

Submitted by: e3endocl  
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Plot Date: 26-AUG-2005 11:12



KEY PLAN  
SCALE: 1:500

GENERAL NOTES:

1. REFER TO MECHANICAL DRAWINGS FOR THE ACTUAL LOCATION OF MECHANICAL EQUIPMENT.
2. CONVENIENCE RECEPTACLE OUTLET HOME RUNS SHALL BE 2-4MM2, 1-4MM2(G) - 21MM C, UNLESS NOTED OTHERWISE. ISOLATED GROUND RECEPTACLE OUTLET HOMERUNS SHALL BE 2-4MM2, 1-4MM2(G), 1-4MM2(IG) - 21MM C, UNLESS NOTED OTHERWISE.
3. REFER TO MECHANICAL EQUIPMENT CONNECTION SCHEDULE FOR CIRCUITING INFORMATION AND FEEDER SIZES OF MECHANICAL EQUIPMENT.
4. MC CABLE USE SHALL BE LIMITED TO A MAXIMUM LENGTH OF 1830MM.
5. LOCATION OF SWITCHES, RECEPTACLES, PANELS, DISCONNECT SWITCHES, PULL BOXES, AND OTHER DEVICES/EQUIPMENT ARE APPROXIMATE. COORDINATE EQUIPMENT LOCATION WITH OTHER TRADES TO PREVENT INTERFERENCE.
6. REFER TO SITE ELECTRICAL PLAN FOR OUTDOOR POWER WORK.
7. DRAWING SHOWS THE CORRECT NUMBER OF RECEPTACLE OUTLETS AND DATA/COMM JACKS. FINAL LOCATION OF DEVICES MAY CHANGE TO ACCOMMODATE THE FINAL FURNITURE ARRANGEMENT.
8. COORDINATE LOCATION OF LIGHT SWITCH AND RECEPTACLE IN ELEVATOR PIT WITH ELEVATOR SHOP DRAWINGS. LIGHT FIXTURE SHALL BE ENCLOSED AND GASKETED, WALL MOUNTED, 150W INCANDESCENT WITH GLOBE AND GUARD - APPLETON #VPWB1075G OR EQUAL.
9. PROVIDE A CIRCUIT FOR ELEVATOR LIGHTS, VENTILATION AND TELEPHONE OUTLET FOR ELEVATOR TELEPHONE. MOUNT TELEPHONE OUTLET AT MIDWAY OF THE SHAFT.
10. 2-4" RGS UP TO COMM. ROOM ON 2ND FLOOR, TERMINATED 4" ABOVE FLOOR SLAB AND PROVIDE GROUND BUSHING.
11. COORDINATE WITH DOCK-LOK SHOP DWG. AND PROVIDE EXTENSION OF WIRING TO PIT AS REQUIRED.
12. REFER TO DWG E-601, SINGLE LINE DIAGRAM FOR FEEDER SIZES.
13. REFER TO DWG E-604 FOR MECHANICAL EQUIPMENT CIRCUIT SCHEDULE.
14. REFER TO DWG E-503 FOR ARMS VAULT SECURITY BLOCK DIAGRAM. COORDINATE WITH FORT DRUM PW IDS TECHNICIAN PRIOR TO INSTALLATION.



